


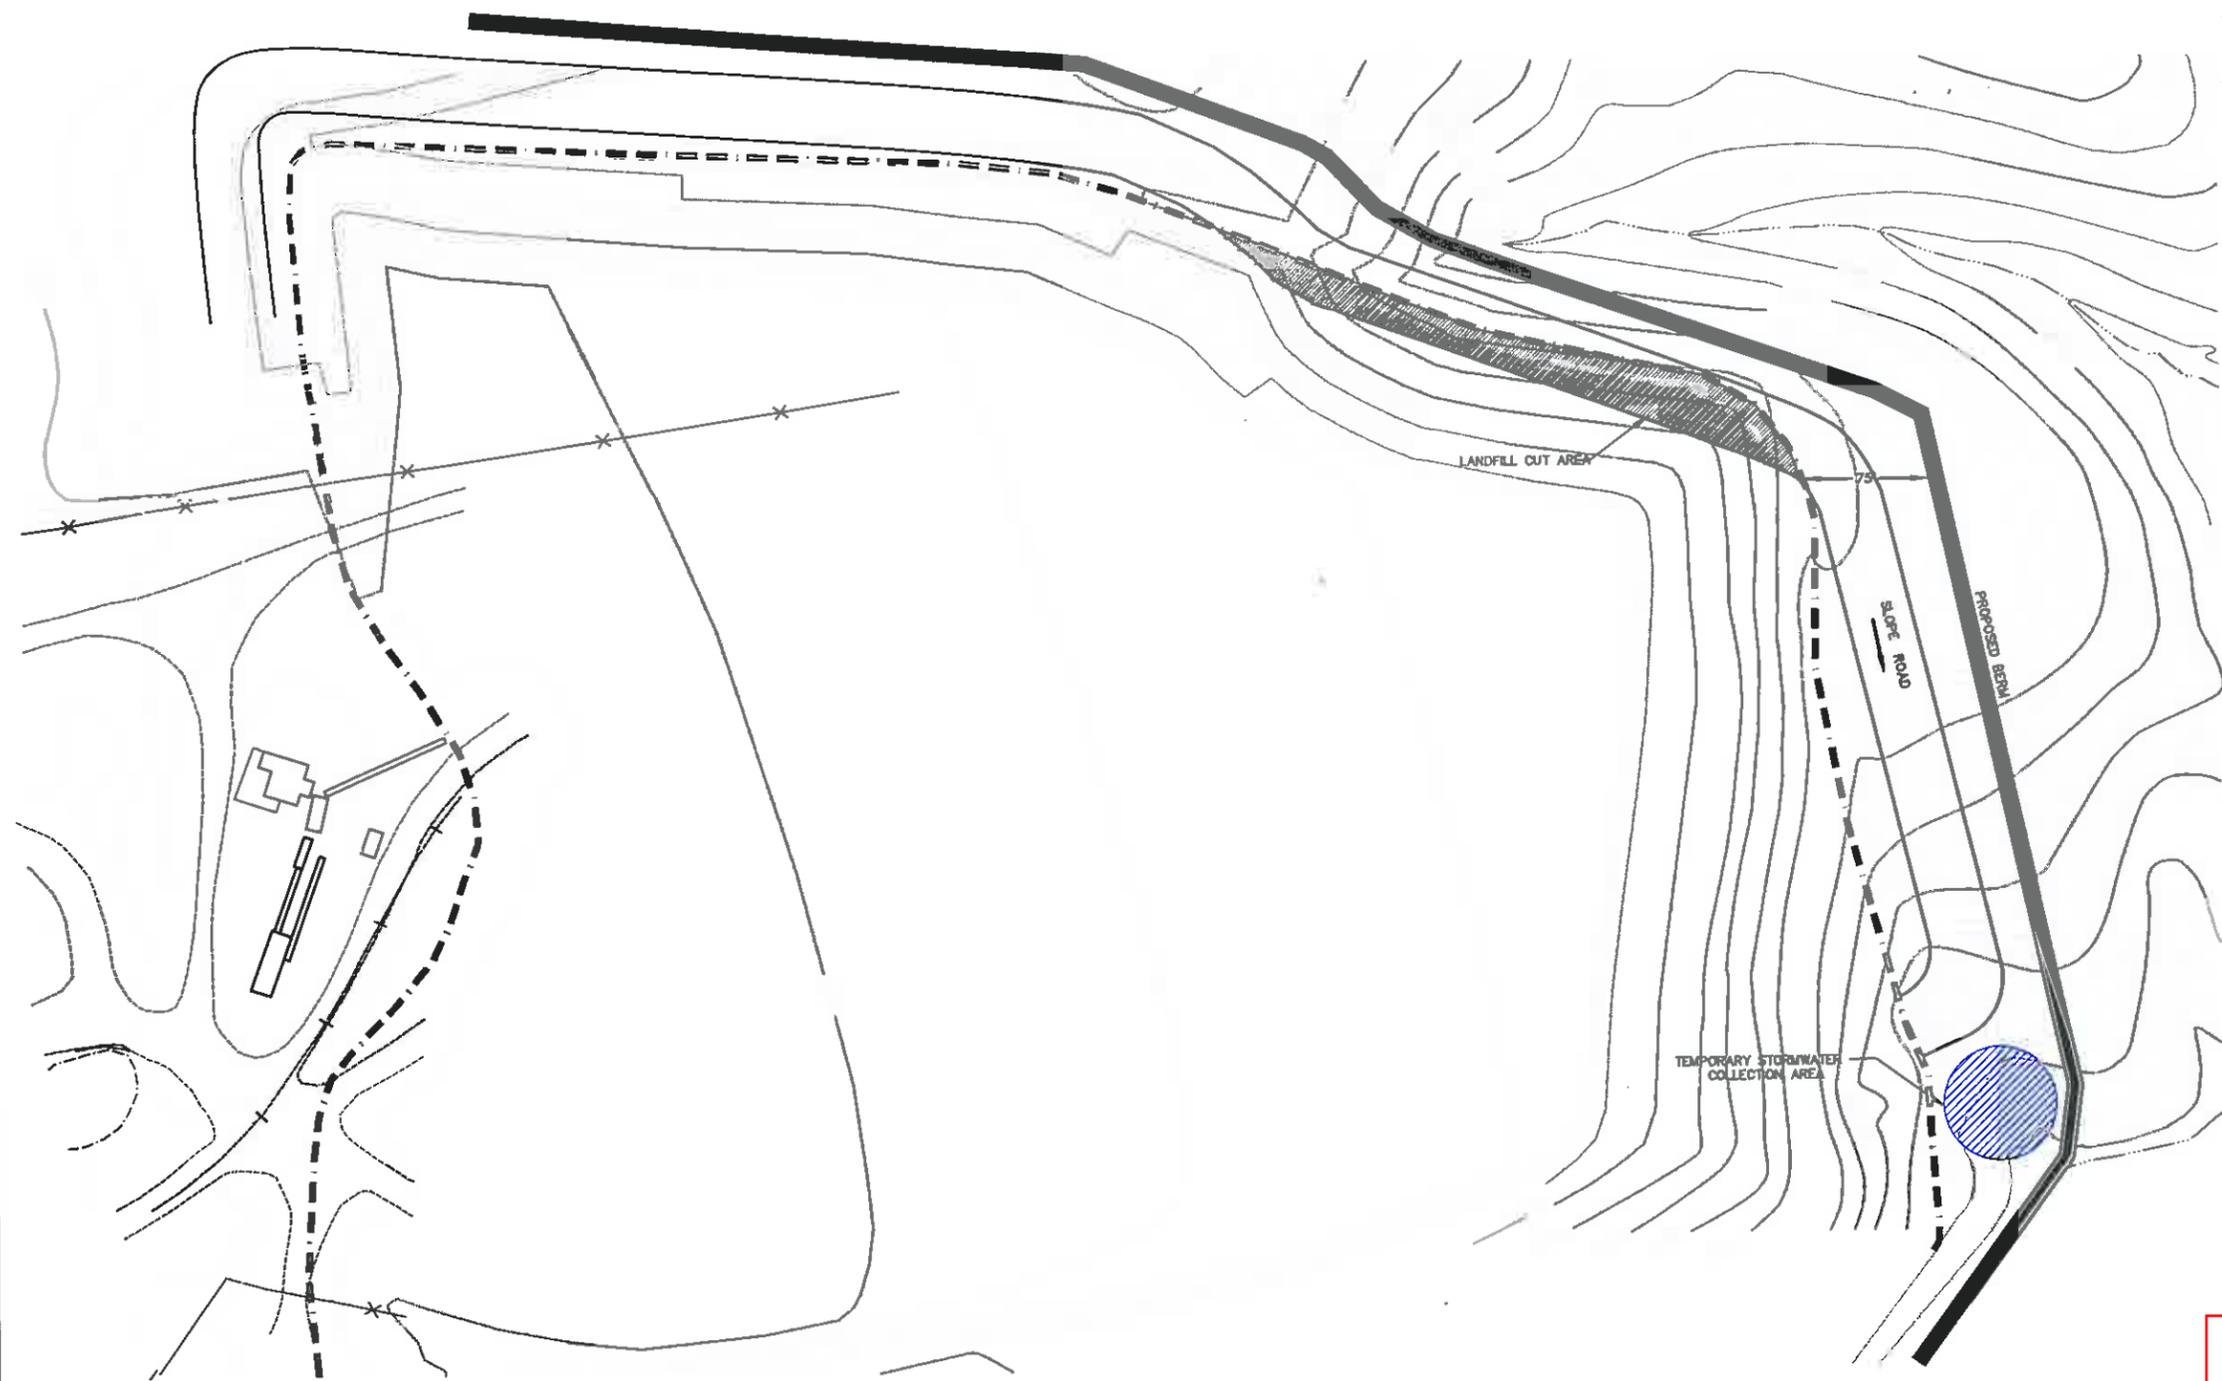

- NOTES:
1. EARTHEN BERM IS TO BE CONSTRUCTED WITH CLEAN SOIL EXCAVATED FROM THE BORROW AREA WEST OF THE EXISTING LANDFILL.
 2. SOIL FOR THE BERM IS TO BE PLACED IN 8 INCH LIFTS AND COMPACTED TO 90% STANDARD PROCTOR DENSITY.
 3. PRIOR TO THE PLACEMENT OF ANY SOIL FOR THE BERM THE AREA UNDER THE BERM WILL BE GRADED TO A UNIFORM SLOPE AND ALL ORGANIC MATERIAL REMOVED.
 4. THE TEMPORARY STORMWATER COLLECTION AREA WILL BE MOVED WEST ACROSS THE TOE OF THE LANDFILL AS THE INDIVIDUAL LANDFILL ZONES ARE REFILLED WITH PROCESSED MATERIAL.
 5. FOLLOWING A RAINFALL EVENT THE OPERATOR WILL MONITOR FLOW IN THE NATURAL DRAINAGE BELOW THE BORROW AREA. WHEN RUNOFF FROM THE BORROW AREA HAS RETURNED TO A PRE-STORM LEVEL, THE WATER IN THE TEMPORARY STORMWATER COLLECTION AREA WILL BE PUMPED TO ONE OF THE EXISTING EROSION CONTROL STRUCTURES.



DIN 20714
Rec'd 3/10/2014

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BAR IS ONE INCH ON ORIGINAL DRAWING 0 ————— 1"		W.Z. BAUMGARTNER & ASSOCIATES, INC. ENVIRONMENTAL ENGINEERS AND CONSULTANTS 1113 MURFREESBORO ROAD SUITE 310 WILLIAMSON SQUARE (37064) P.O. BOX 680369 FRANKLIN, TENNESSEE 37068-0369 615-595-0025	SEAL:	DRAWN BY: CLG CHECKED BY: MET ENGINEER: WZB DATE: 02/09/06	MASTER SITE PLAN ATLANTIC SCRAP KERNERSVILLE, NORTH CAROLINA	SCALE: 1" = 50' PROJECT NO.: 25097 SHEET NO.: 1 OF 1
IF NOT ONE INCH ON THIS SHEET, ADJUST SCALES ACCORDINGLY	NO.		REVISIONS	DATE	ENGR	